

JEZZINE – COMPOSTING FACILITY

PROJECT BRIEF

INTRODUCTION:

In Year I, DAWERR started developing sustainable composting value chains for organic waste and strengthening existing Recycling Value Chains (RVCs) for recyclable materials in seven selected municipalities, including Jezzine, as solid waste diversion and valorization pilots (the “pilots”).

As part of the pilots, DAWERR will support Jezzine Municipality and its local community to develop sustainable composting value chains for organic waste (representing 50% of the total municipal solid waste stream) including source separation, collection, and composting of organic waste through the construction of small-scale, low-tech (with spare parts available in the local market), low-cost (capital and O&M) composting stations, creating local demand for the compost produced for agricultural, landscaping, or other uses as soil conditioner/ fertilizer supplement. DAWERR also will facilitate linkages with existing material recovery facilities and engaging the private sector to strengthen value chains for other, non-organic recyclables.

DAWERR is providing targeted technical, financial, and business support to Jezzine Municipality to design, implement, and manage the “pilot”.

SUMMARY OF CONSTRUCTION ACTIVITIES AND PROVISION OF EQUIPMENT

DAWERR will construct a composting station - container composter (see details in the drawings below), for which DAWERR subcontractor Compost Baladi has an exclusive Lebanese patent, provide equipment to Jezzine Municipality as listed below, and conduct training to the Municipality/Operator to operate and maintain the station and ensure its sustainability beyond the life of the Activity as follows:

1. Construction Activities:

a. Municipality Contribution:

The municipality will be responsible for obtaining the necessary permits and approvals for the composting station (including establishment permit and construction permit) from the related authorities and will contribute to the construction works in the selected plot/site (plot#86, Jezzine) that will host the composting station including:

1. The topographic surveys during the project implementation, where needed.
2. Rehabilitation and asphaltting the access road leading to the project's site.
3. The excavation works and the land preparation following the designs, specification and calculations provided by DAWERR civil engineer.
4. The construction of cyclopean concrete walls for the project's fence.
5. Planting trees all around the project's fence.

Municipality work contribution will be implemented under the design and supervision of DAWERR consultant engineer.

b. DAWERR Contribution:

DAWERR will be responsible for the following:

1. The earth works and land's preparation including Base coarse layer, excavation of the foundations, etc.
2. The reinforced concrete works including blinding concrete, foundations, tie beams, channels and pits, slab on grade, etc.
3. The steel works including: the construction of two steel hangars (Blocks A&B), The steel fence, the project's gates, etc.
4. Finishing for the Block A and B (as shown in top of Roof Plan drawing) including partition - plastering - painting - doors, windows, tiling, etc.
5. Electrical installation including power, lighting and low current, networks, earthing, etc.
6. Mechanical installation including drainage and water supply networks, sanitary fixtures for the reception's toilet, etc.
7. Landscaping works including the asphaltting of the external yards, etc.

2. Provision of Equipment:

Once the construction phase is completed, DAWERR will provide and install the following equipment:

1. Three container composter 40' with all its related equipment.
2. One container 20' for storage.
3. One screening machine to screen the compost produced.
4. Solar Photovoltaic (PV) system for the Electrical power supply. (To be confirmed; not included in this submission)

Important Note:

This submission is an intermediary design and will be used by the municipality in the permit's acquisition process.

The detailed drawings, calculation notes, tests, etc., will be submitted after the permit issuance.

JEZZINE COMPOSTING FACILITY LIST OF ARCHITECTURAL INTERMEDIARY DESIGN DRAWINGS

Sheet Number	SHEET TITLE	SCALE
A-00	LIST OF DRAWINGS – PROJECT BRIEF	N.T.S.
A-01	MASS PLAN	1/1000
A-02	SCHEMATIC SANITARY PLAN	1/100
A-03	SCHEMATIC FOUNDATIONS PLAN	1/100
A-04	GROUND FLOOR PLAN	1/100
A-05	TOP OF ROOF PLAN	1/100
A-06	SECTIONS AA & BB	1/100
A-07	ELEVATIONS	1/100
A-08	PRODUCTION LINE AND EQUIPMENT	1/100



ACTIVITY:

DAWERR

PILOT:

JEZZINE MUNICIPALITY

ENGINEER:

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GENERAL NOTES:
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3-ALL LEVELS ARE IN METERS.

KEY PLAN:

REV.	DATE	MODIFICATION	DRAWN	DESIGNED	CHECKED
2	20/07/2022	REV2-INTERMEDIARY DESIGN	RM	CA	RHE
1	20/05/2022	REV1-INTERMEDIARY DESIGN	RM	CA	RHE
0	14/04/2022	INTERMEDIARY DESIGN	RM	CA	RHE

LOT:

JEZZINE 86

Project Name



COMPOSTING STATION
JEZZINE – SOUTH

DRAWING TITLE:

LIST OF DRAWINGS –
PROJECT BRIEF &
GENERAL NOTES

DRAWING NUMBER A00

SCALE : N.T.S. DATE : 20/07/2022

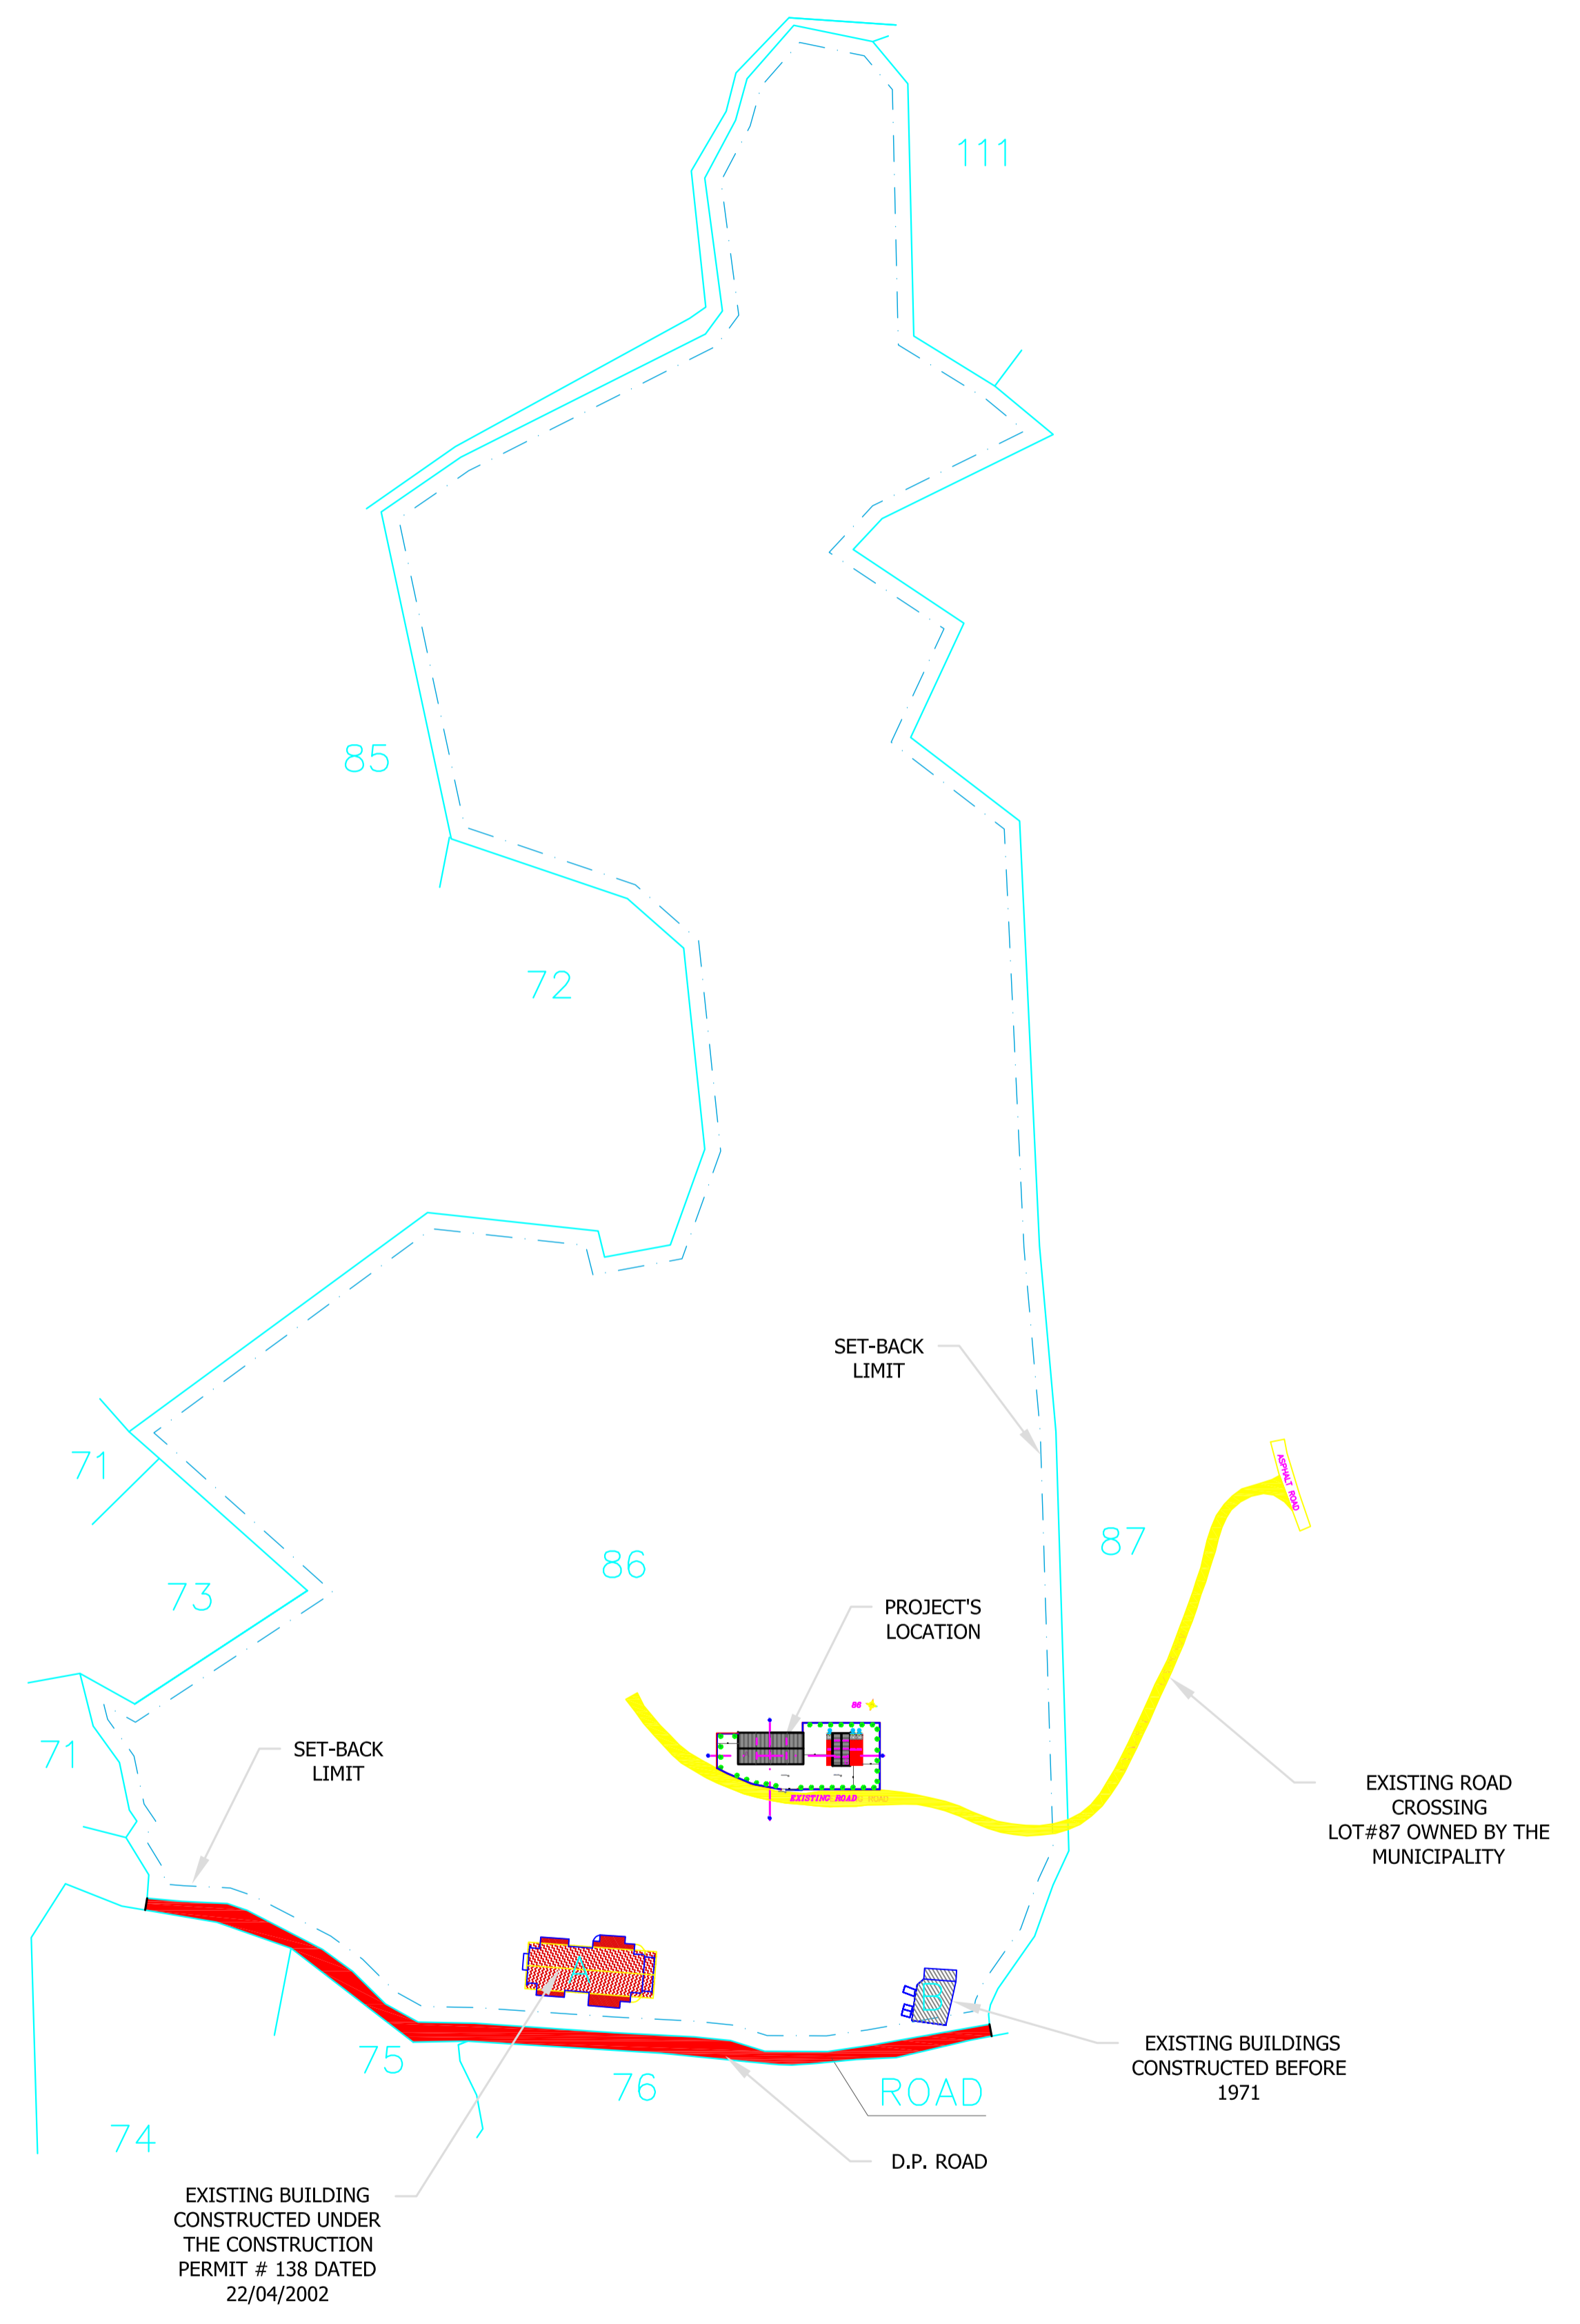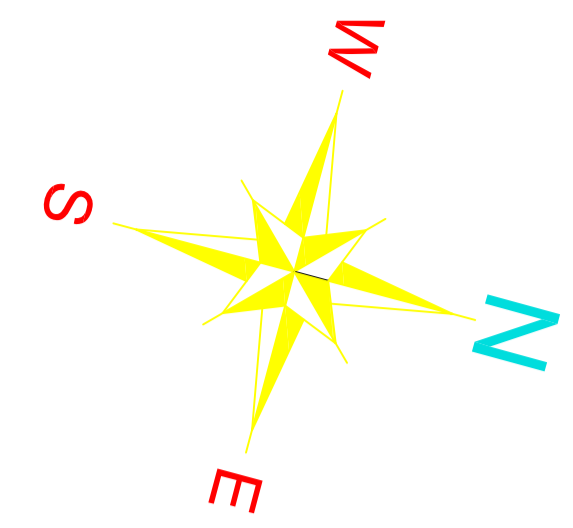

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LOT:
JEZZINE 86

Project Name
**COMPOSTING STATION
JEZZINE - SOUTH**

DRAWING TITLE:
MASS PLAN

DRAWING NUMBER **A01**

SCALE : **1/2000** DATE : **20/07/2022**

EXISTING BUILDING
CONSTRUCTED UNDER
THE CONSTRUCTION
PERMIT # 138 DATED
22/04/2002

EXISTING BUILDINGS
CONSTRUCTED BEFORE
1971

EXISTING ROAD
CROSSING
LOT#87 OWNED BY THE
MUNICIPALITY


SET-BACK
LIMIT

SET-BACK
LIMIT

PROJECT'S
LOCATION

D.P. ROAD

ROAD

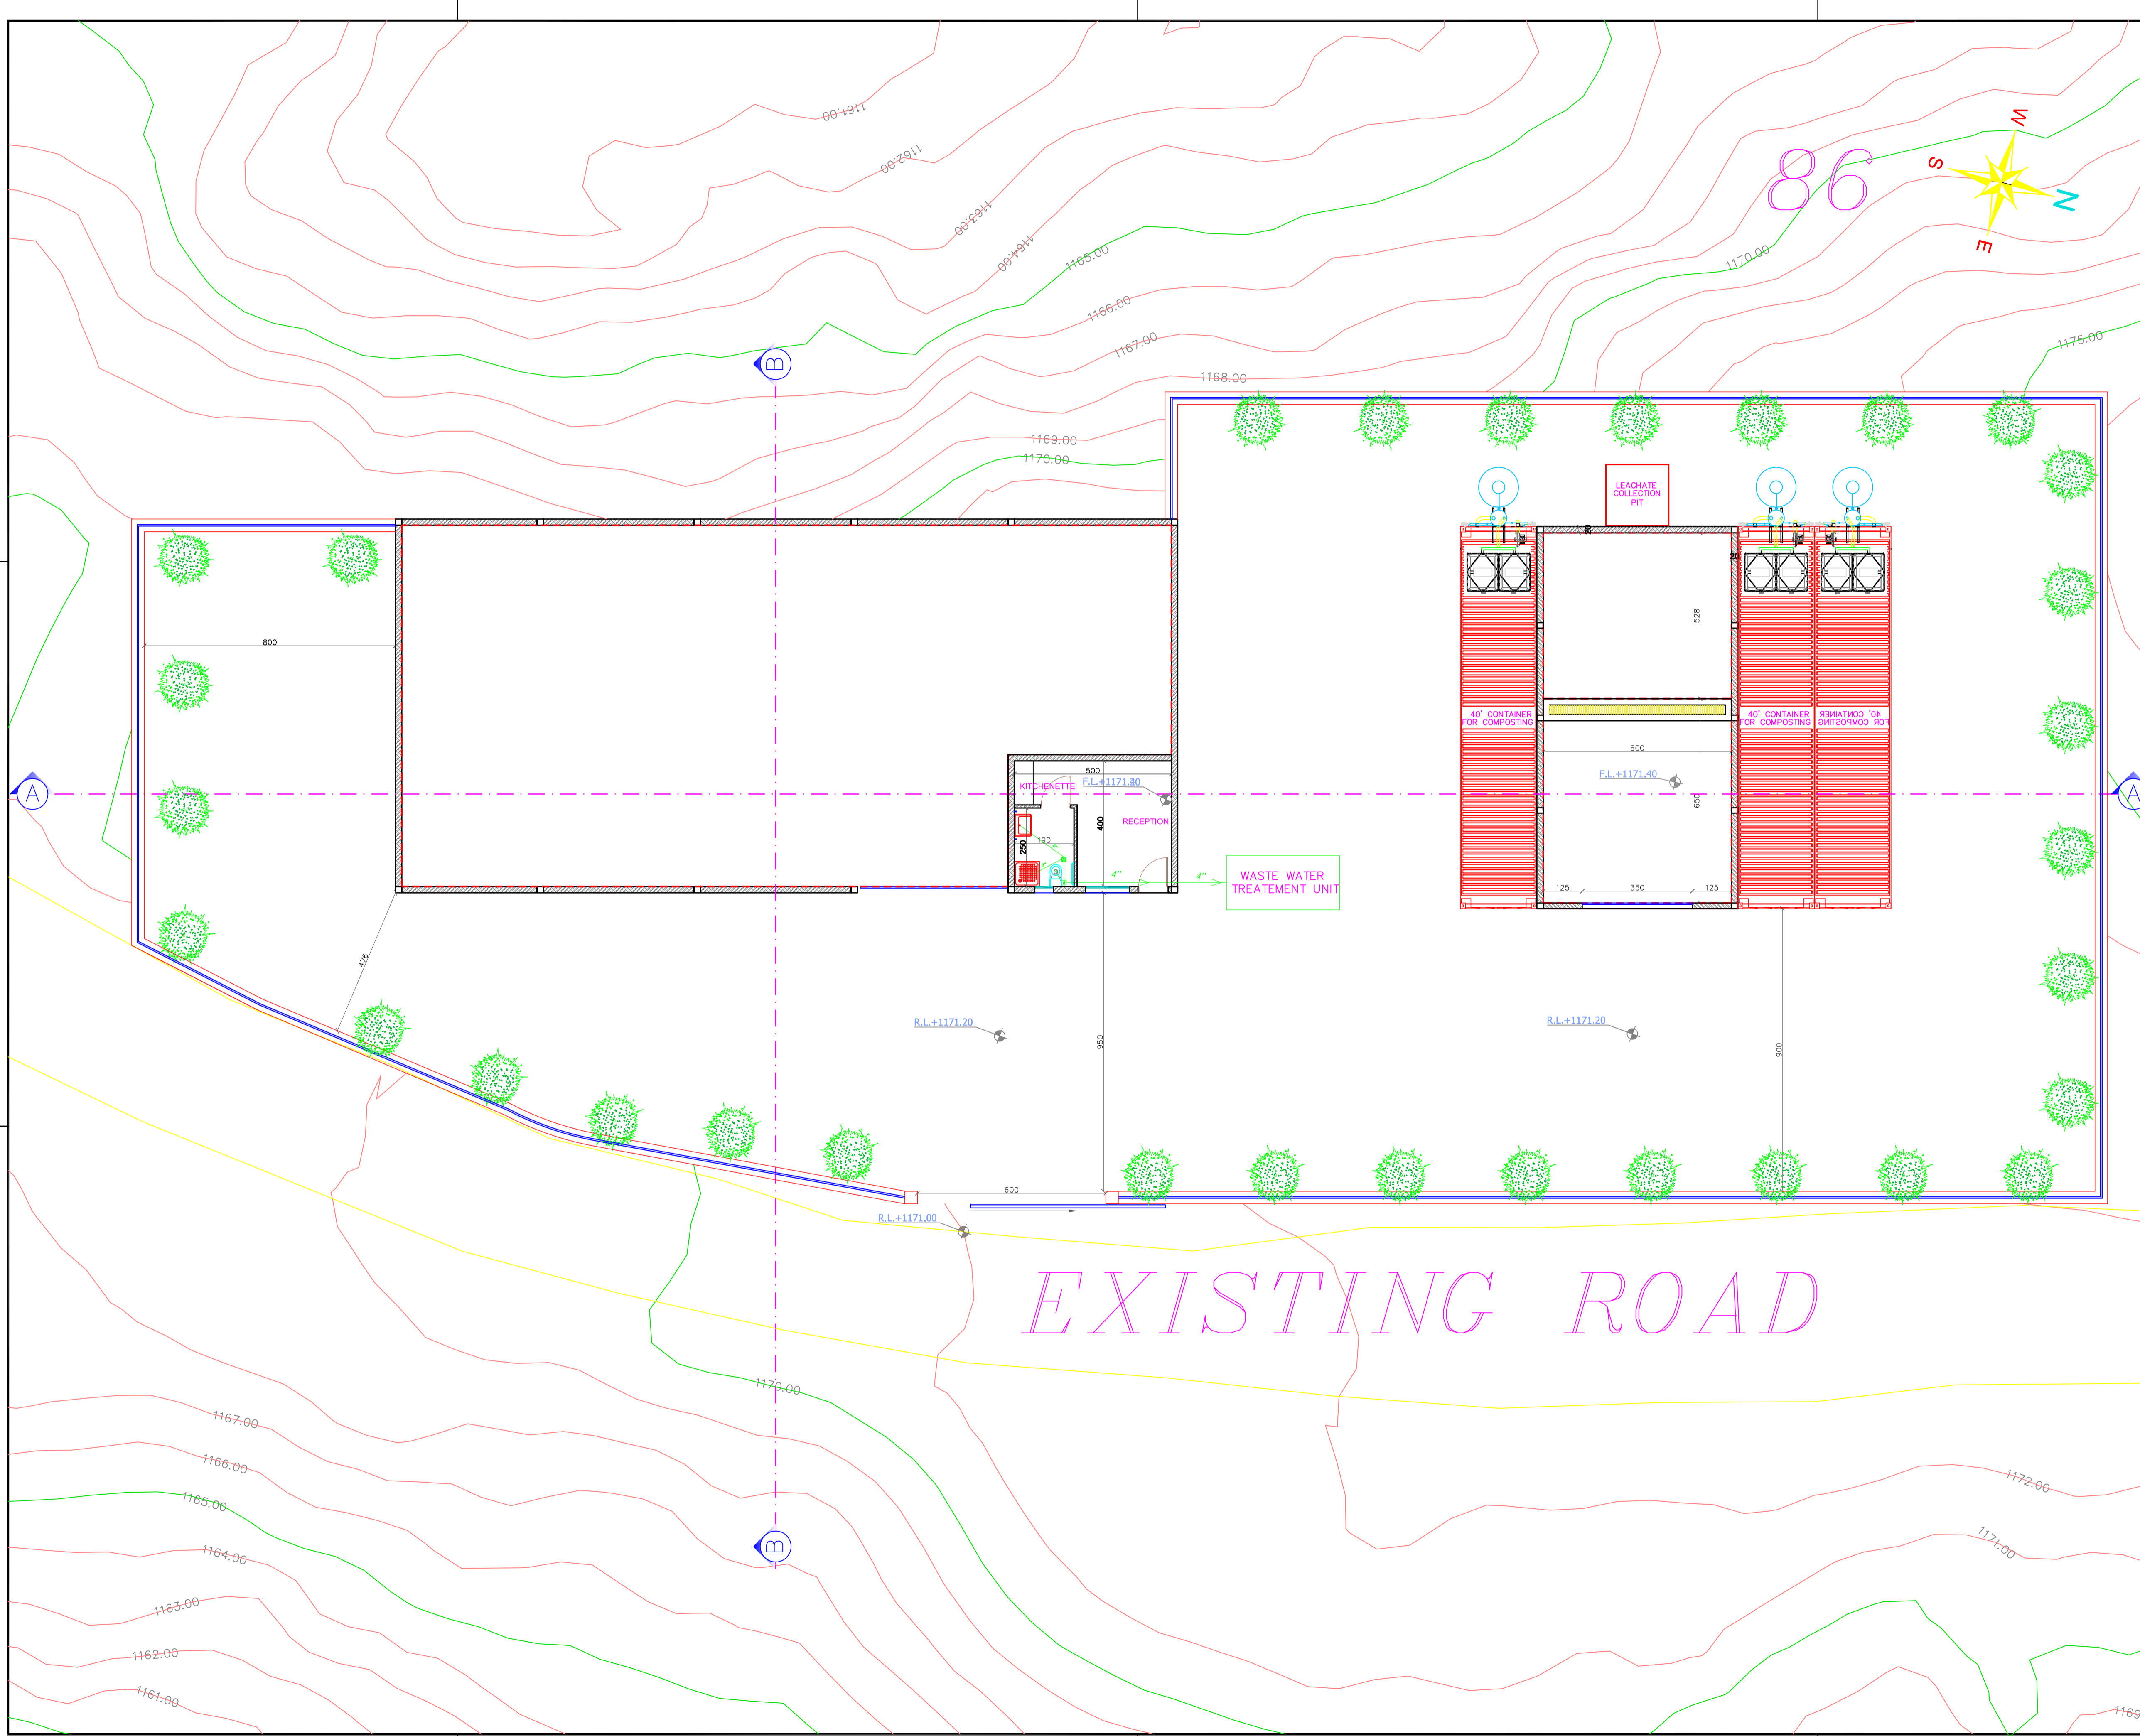

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LOT:

JEZZINE 86

Project Name

COMPOSTING STATION
JEZZINE - SOUTH

DRAWING TITLE:

SCHEMATIC SANITARY
PLAN


DRAWING NUMBER

A02

SCALE :

1/100

DATE : 20/07/2022

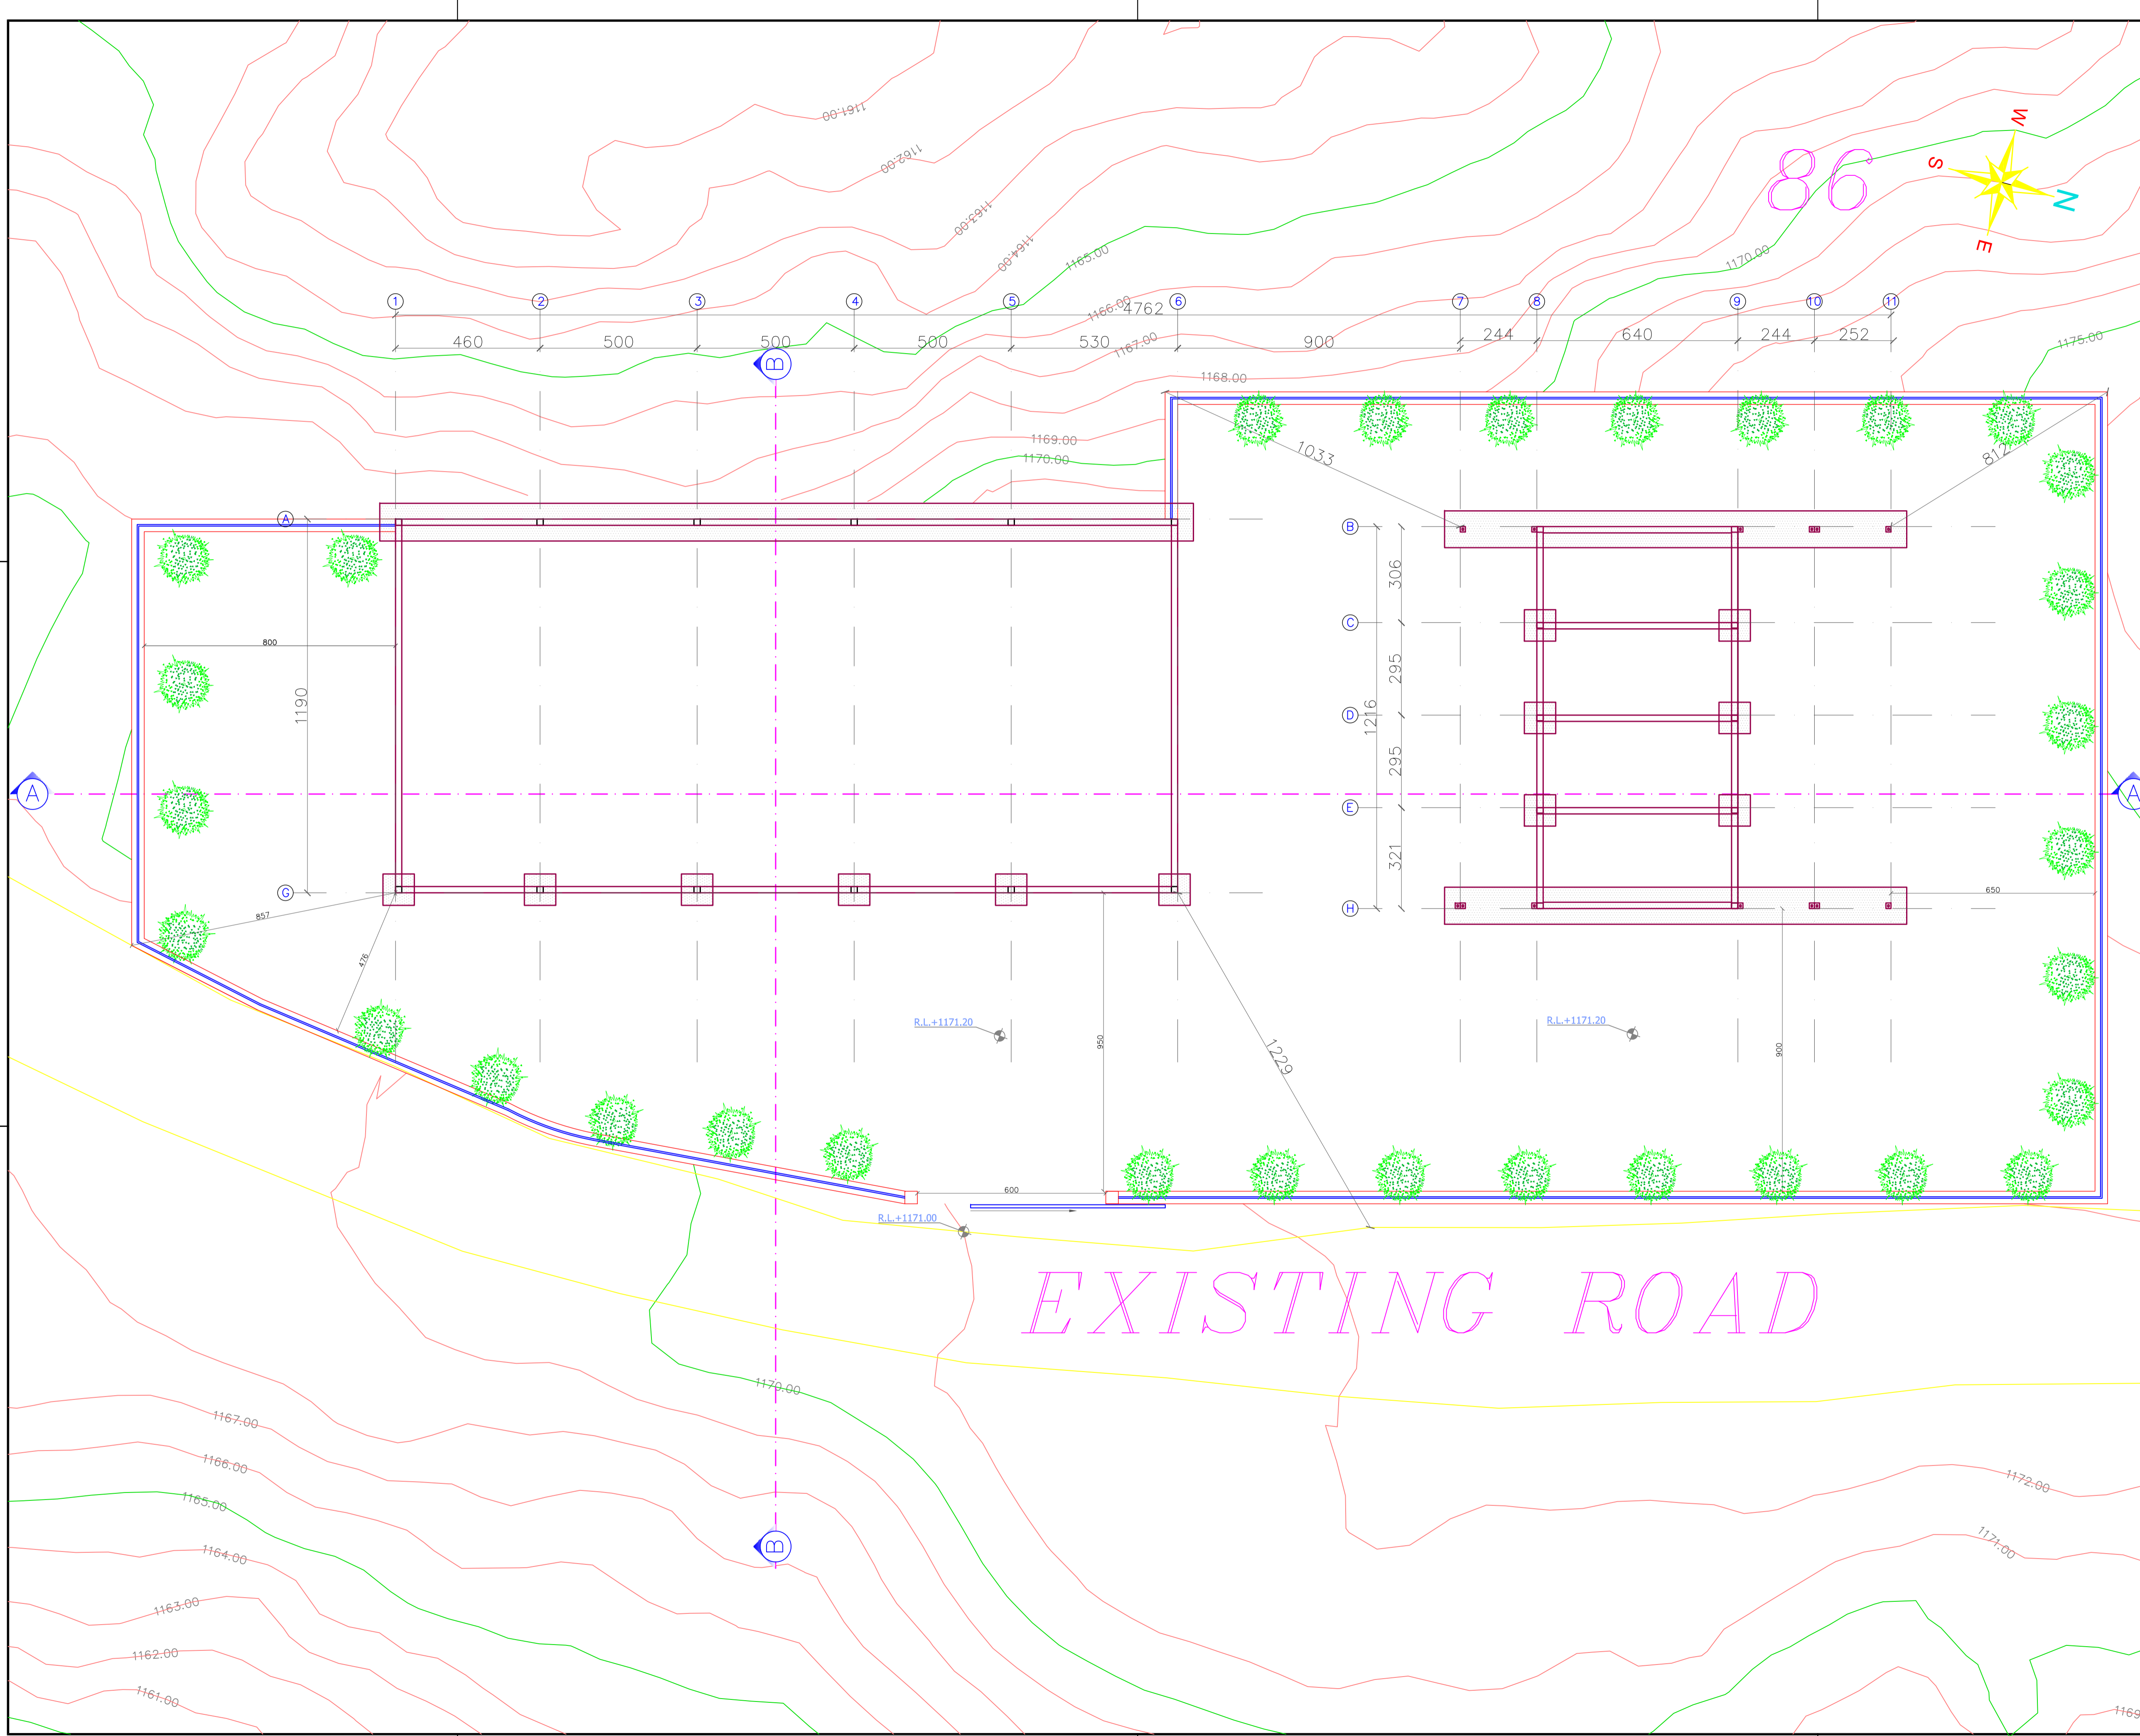

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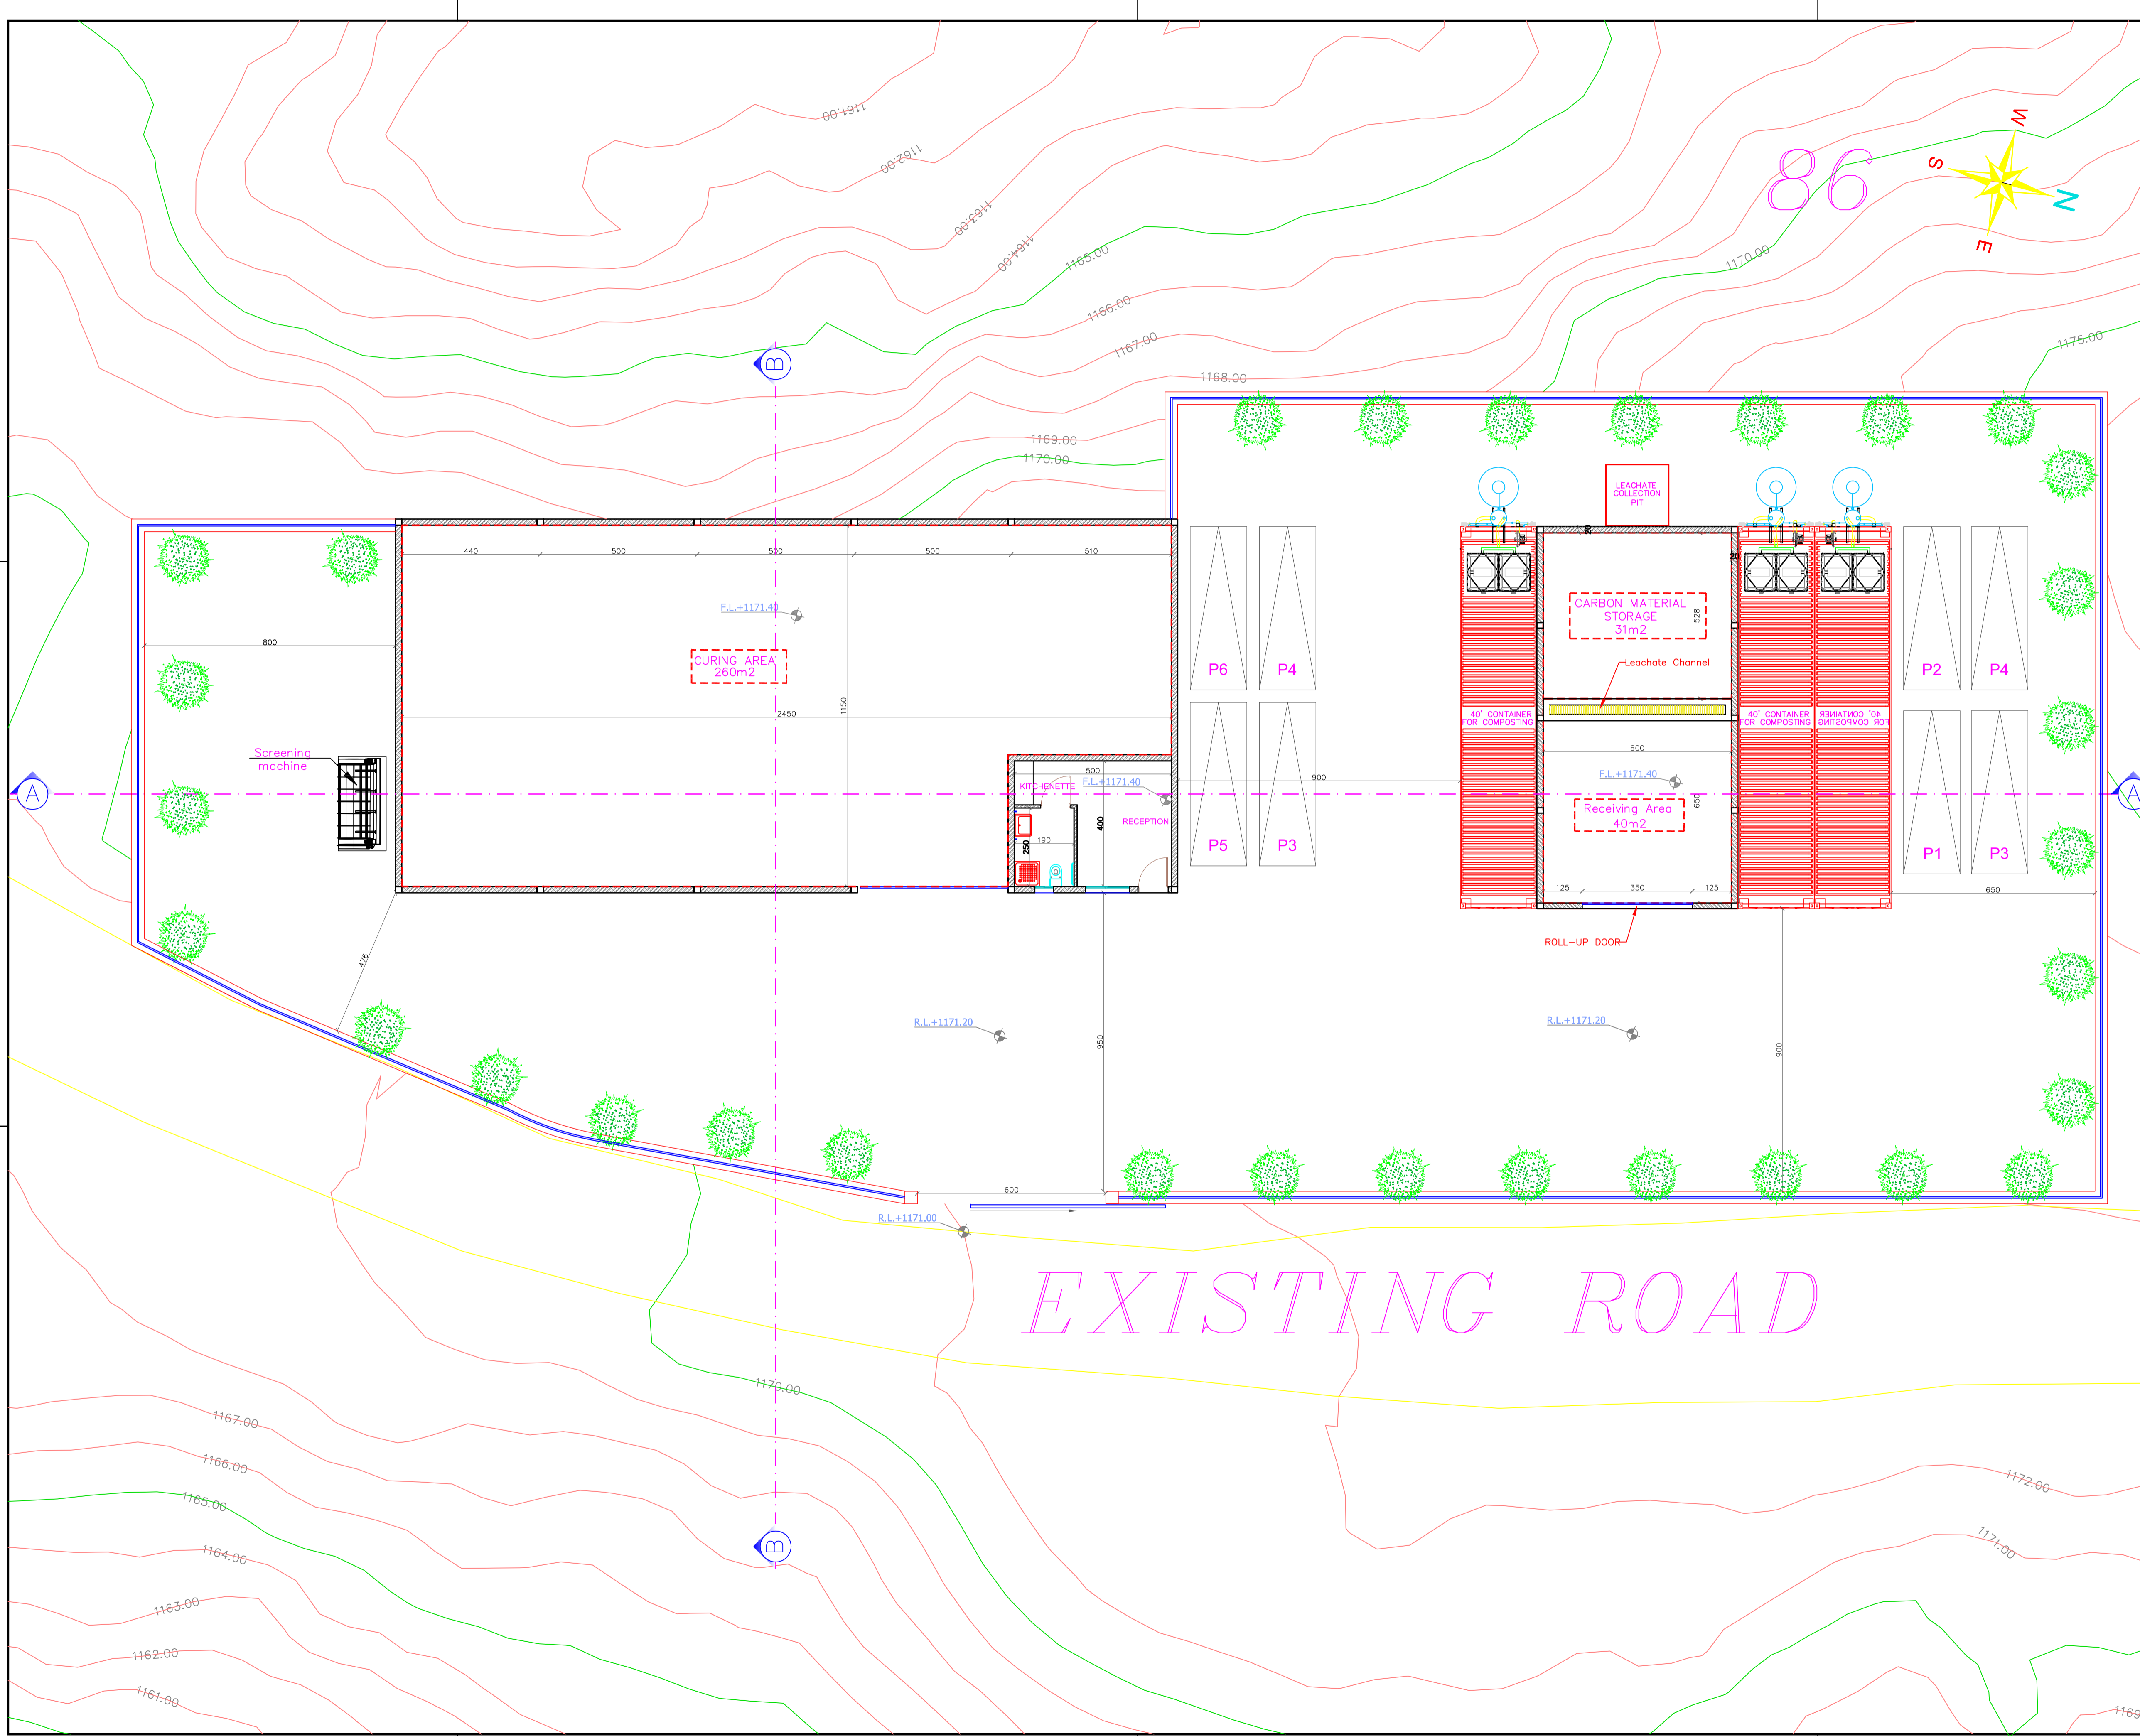
LOT:
JEZZINE 86

Project Name
**COMPOSTING STATION
JEZZINE - SOUTH**

DRAWING TITLE:
**SCHEMATIC FOUNDATIONS
& IMPLANTATION PLAN**

DRAWING NUMBER
A03

SCALE : 1/100 DATE : 20/07/2022



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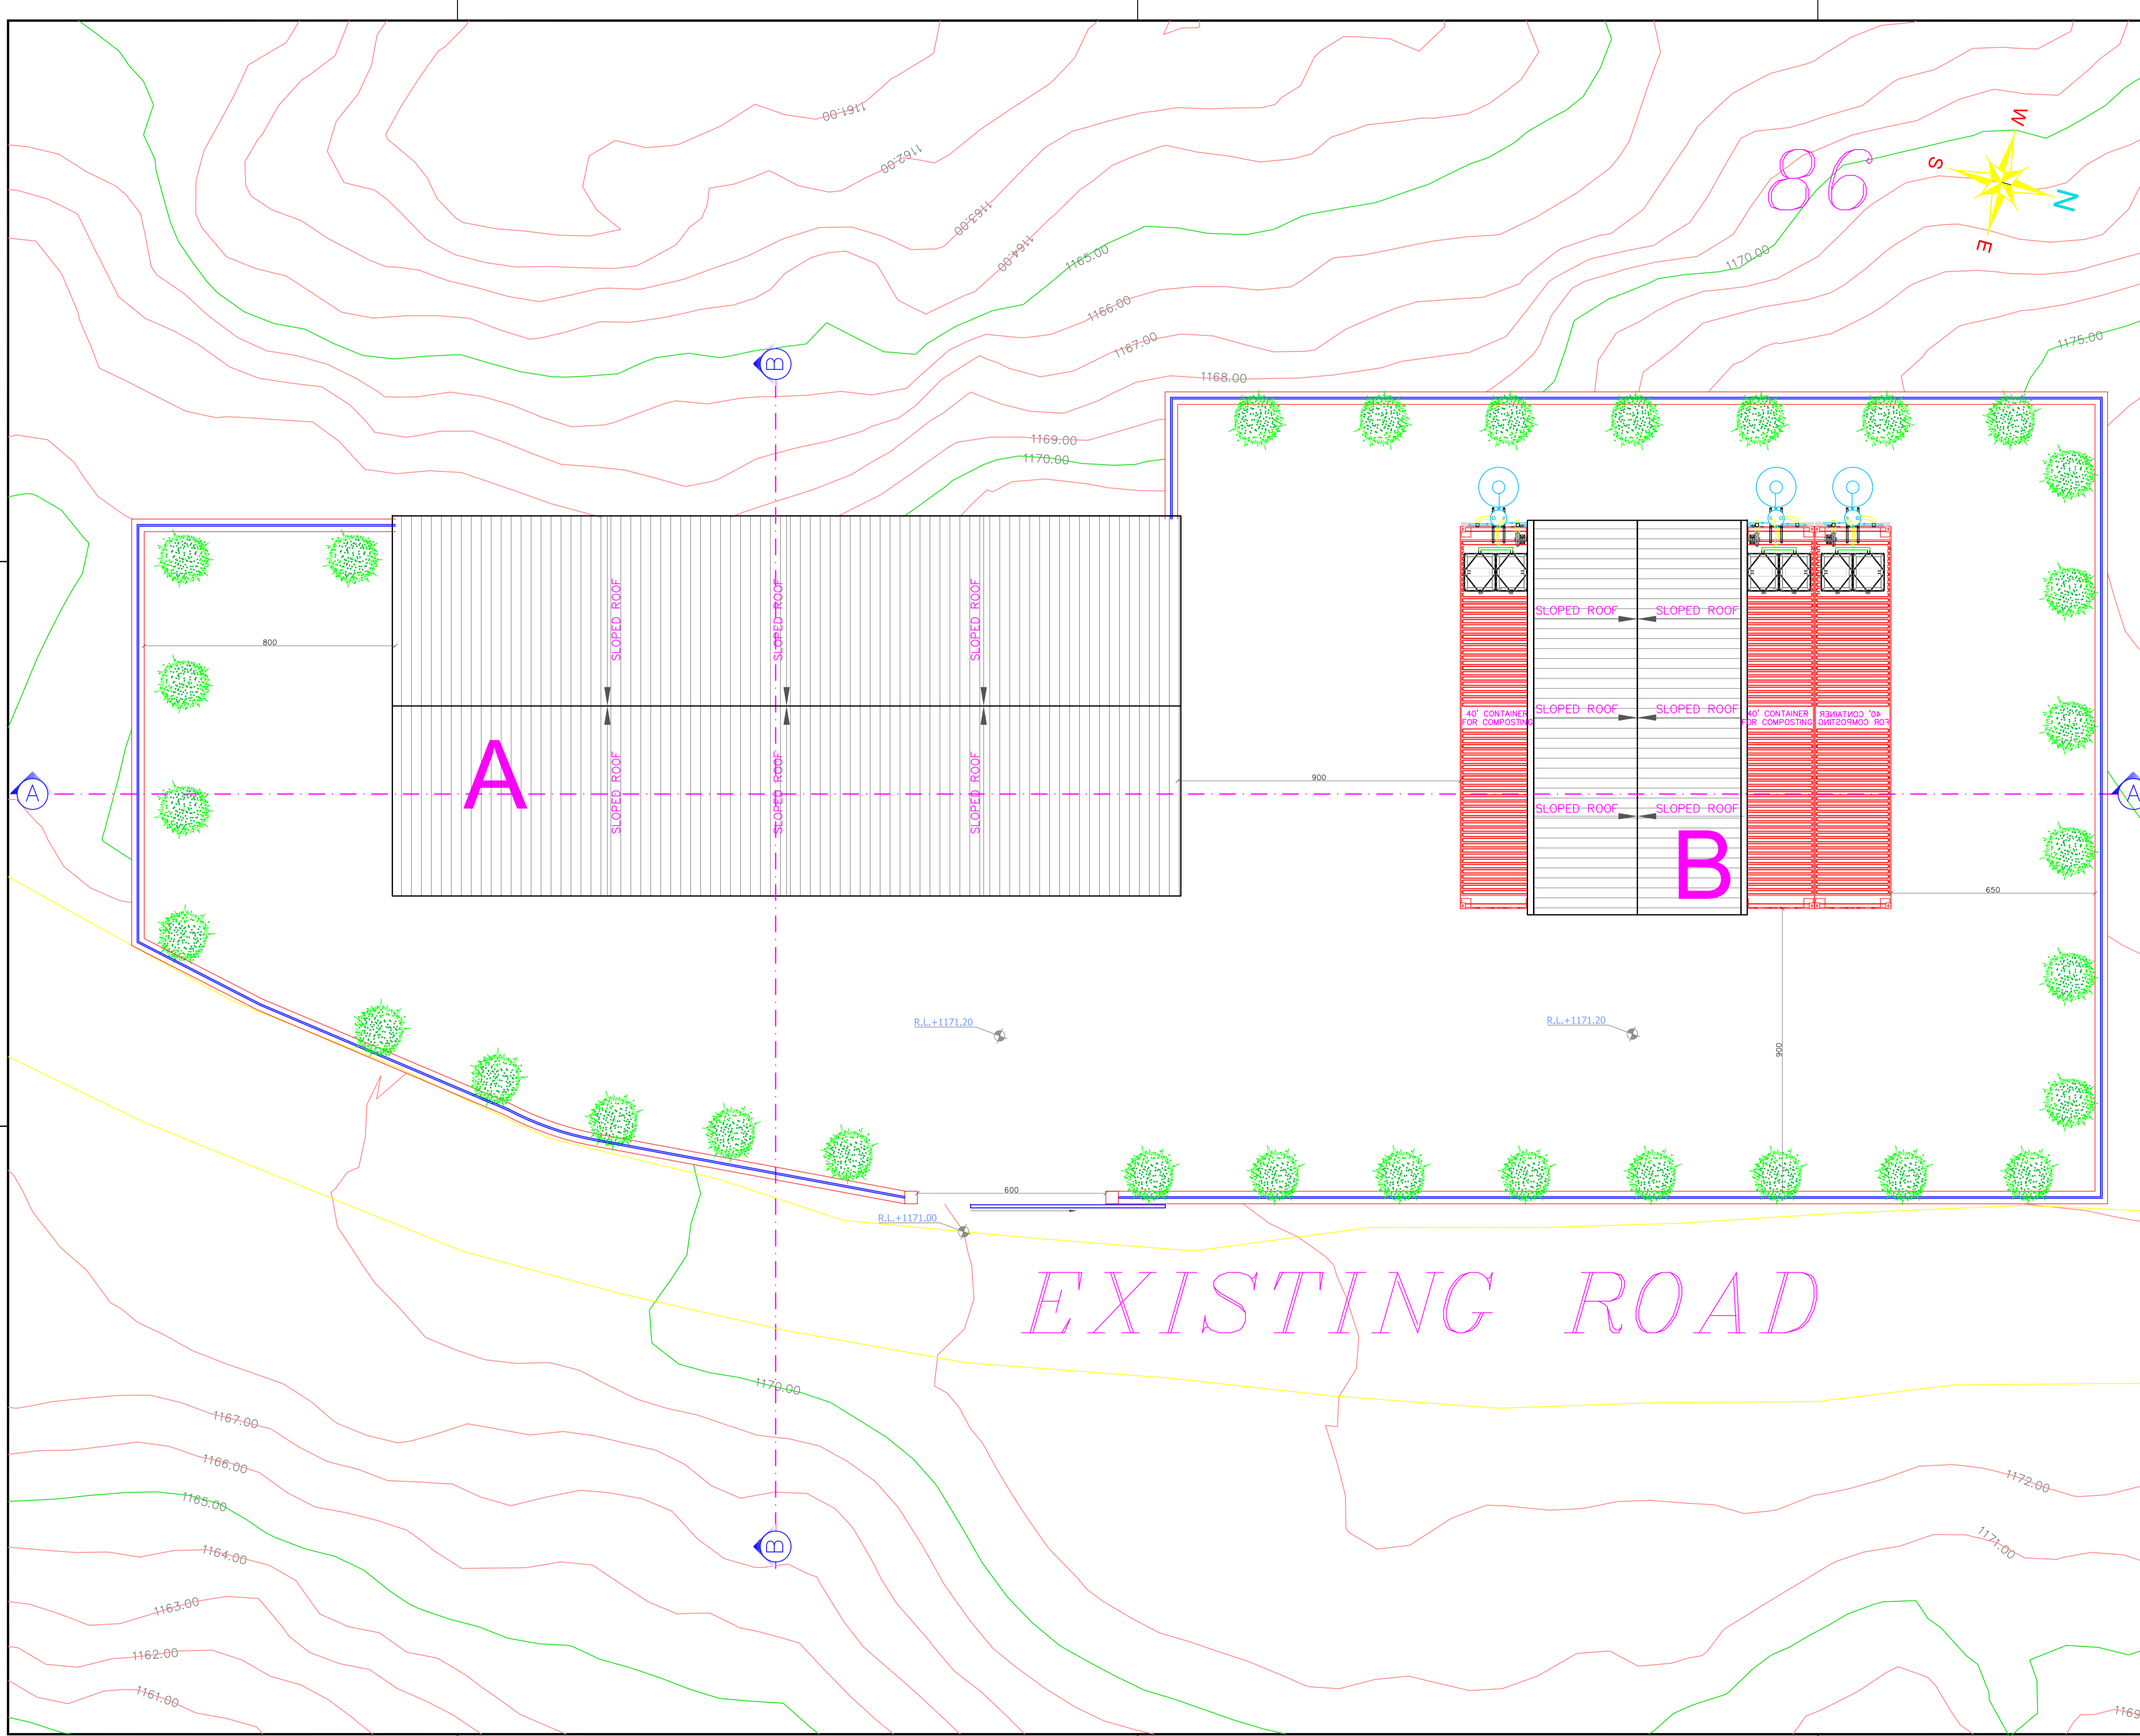
LOT:
JEZZINE 86

Project Name
**COMPOSTING STATION
JEZZINE - SOUTH**

DRAWING TITLE:
**GROUND FLOOR
PLAN**

DRAWING NUMBER **A04**

SCALE : 1/100 DATE : 20/07/2022



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LOT:
JEZZINE 86

Project Name
COMPOSTING STATION
JEZZINE - SOUTH

DRAWING TITLE:
TOP OF ROOF
PLAN

DRAWING NUMBER A05

SCALE : 1/100 DATE : 20/07/2022



USAID
DIVERTING WASTE BY
ENCOURAGING REUSE
AND RECYCLING
DAWERR

ACTIVITY:

DAWERR


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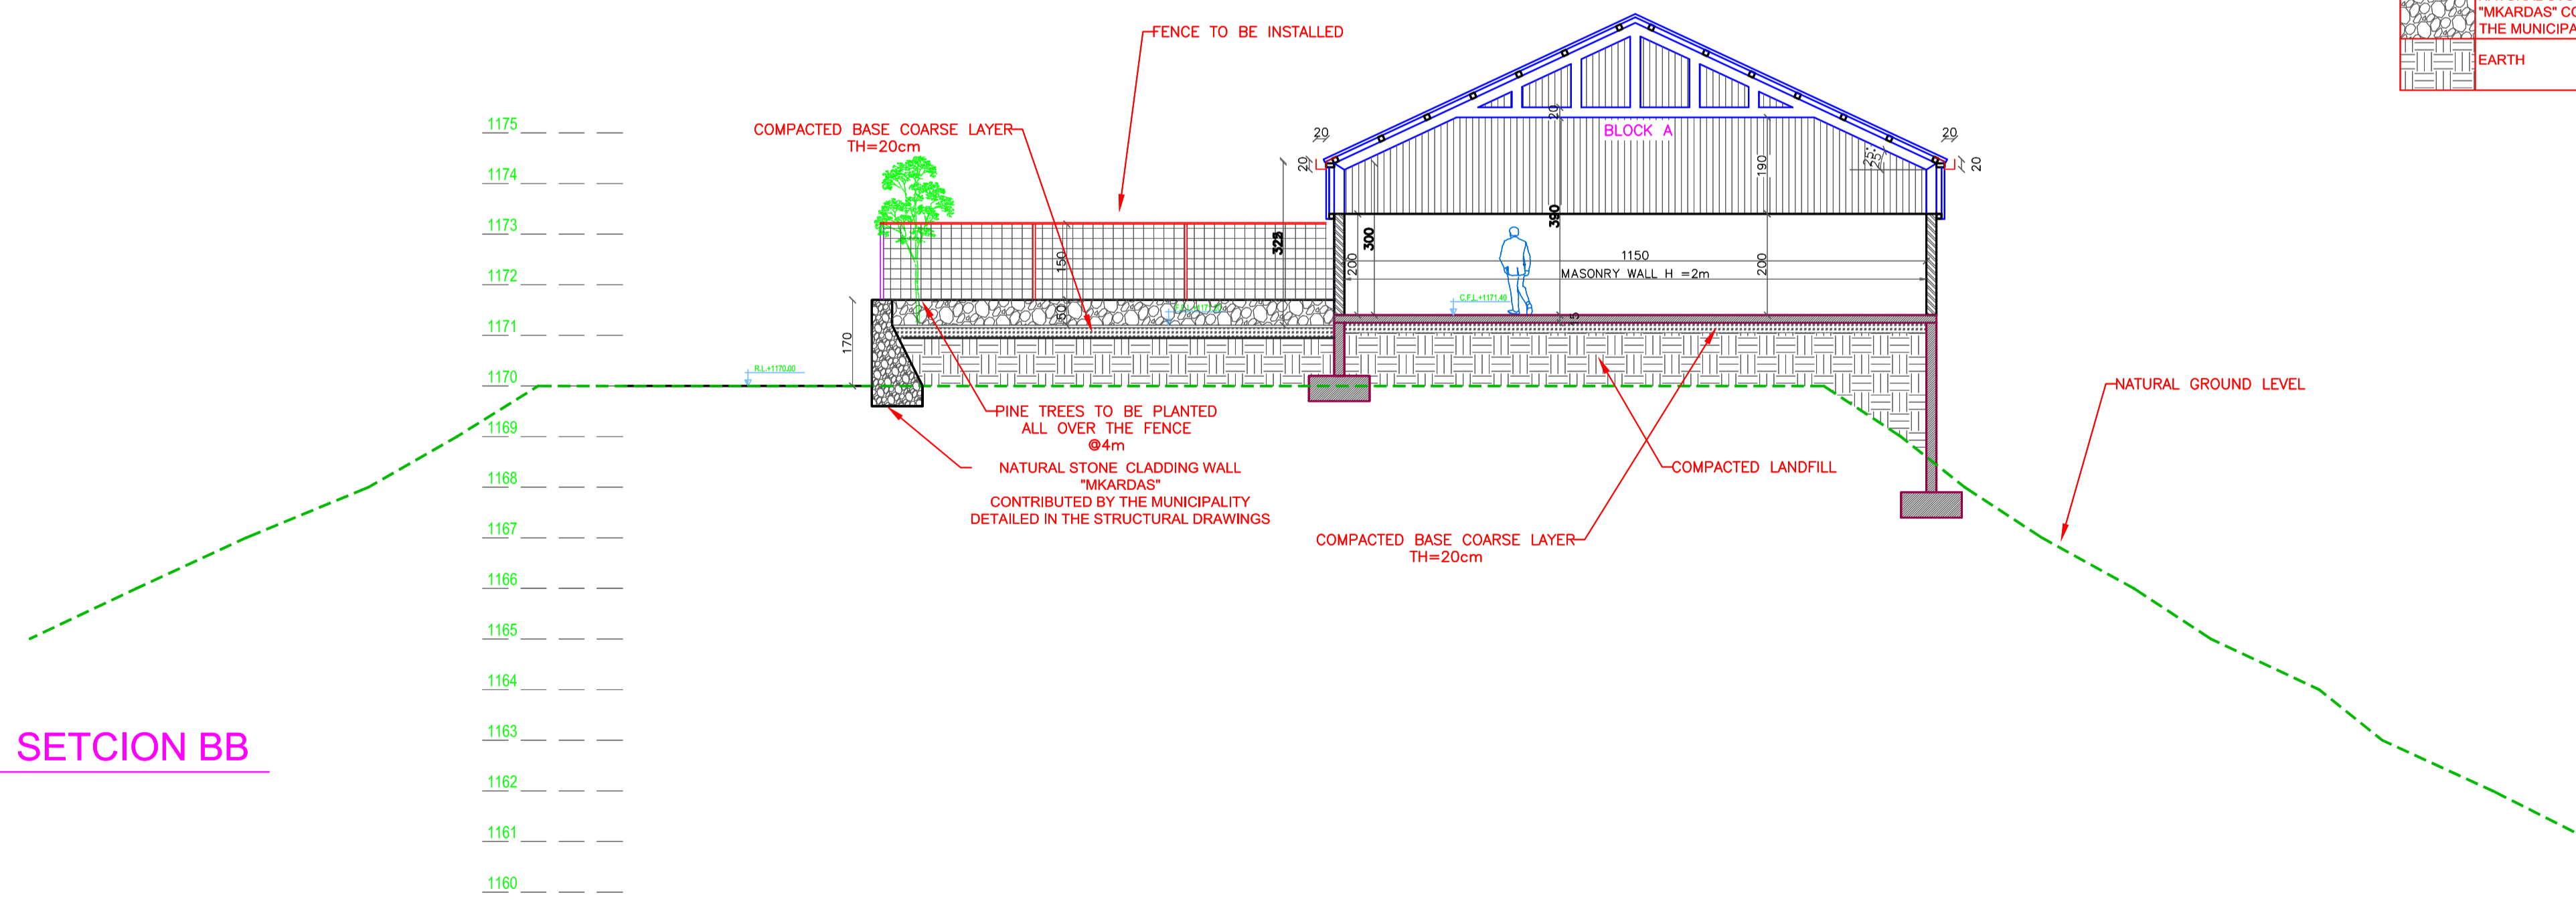
SETCION AA

HATCHES REFERENCES

PATTERN	DESCRIPTION
	CORRUGATED G.I. STEEL ROOF SHEETING - 1.5mm THICK.
	MASONRY BLOCK WALL.
	REINFORCED CONCRETE STRUCTURAL ELEMENT.
	COMPACTED BASE-COARSE LAYER 98% PROCTOR.
	METALIC FENCE - MESH 50x50 - Th=4mm
	NATURAL STONE CLADDING WALL "MKARDAS" CONTRIBUTED BY THE MUNICIPALITY.
	EARTH

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KEY PLAN:

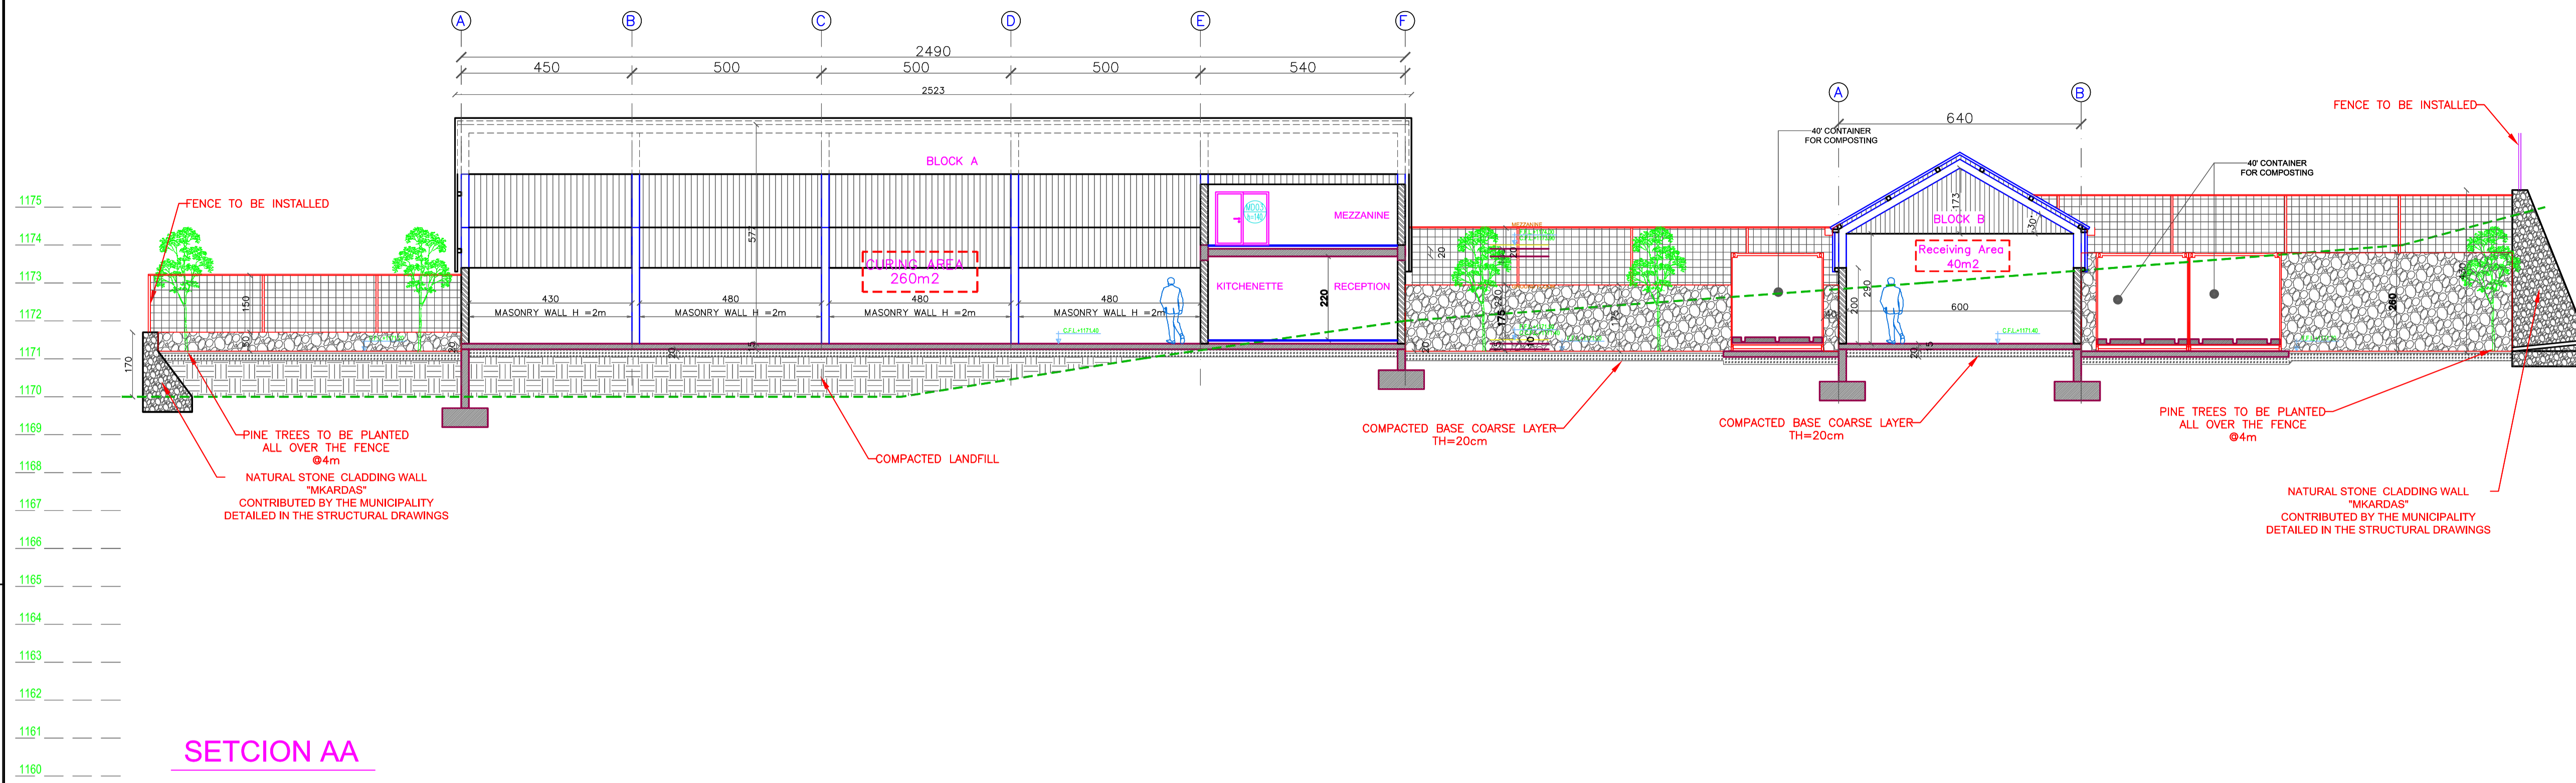

SETCION BB

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LOT:

JEZZINE 86

Project Name

COMPOSTING STATION
JEZZINE - SOUTH

DRAWING TITLE:

SECTIONS AA & BB

DRAWING NUMBER

A06

SCALE :

1/100

DATE :

20/07/2022



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LOT:

JEZZINE 86

Project Name


COMPOSTING STATION
JEZZINE - SOUTH

DRAWING TITLE:


ELEVATIONS

DRAWING NUMBER A07


SCALE : 1/100 DATE : 20/07/2022

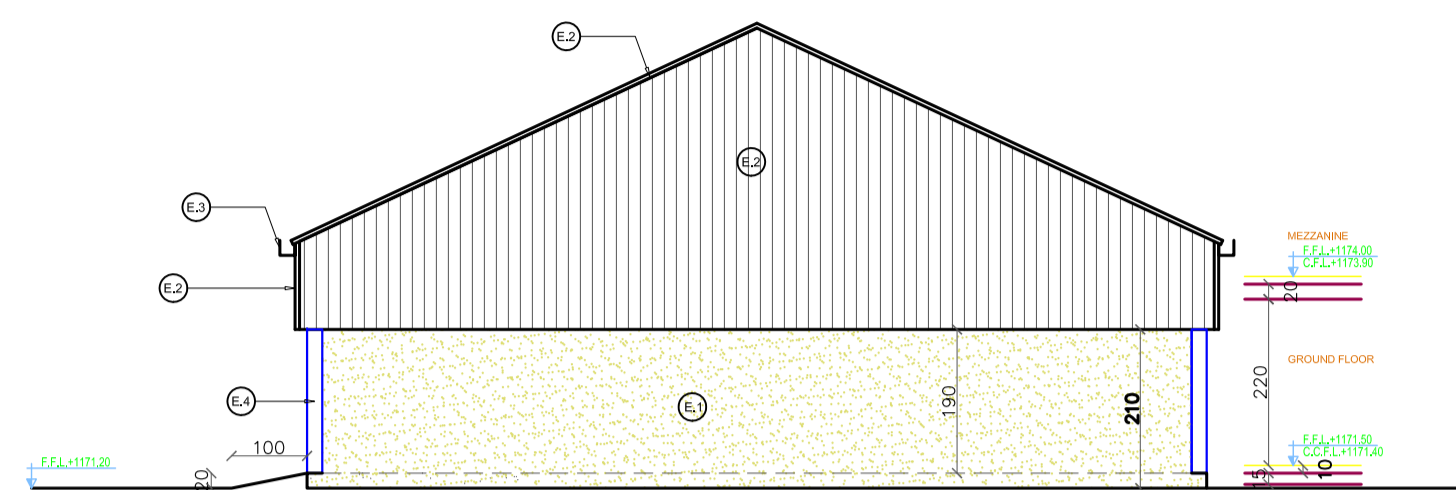


BLOCK A
NORTH ELEVATION

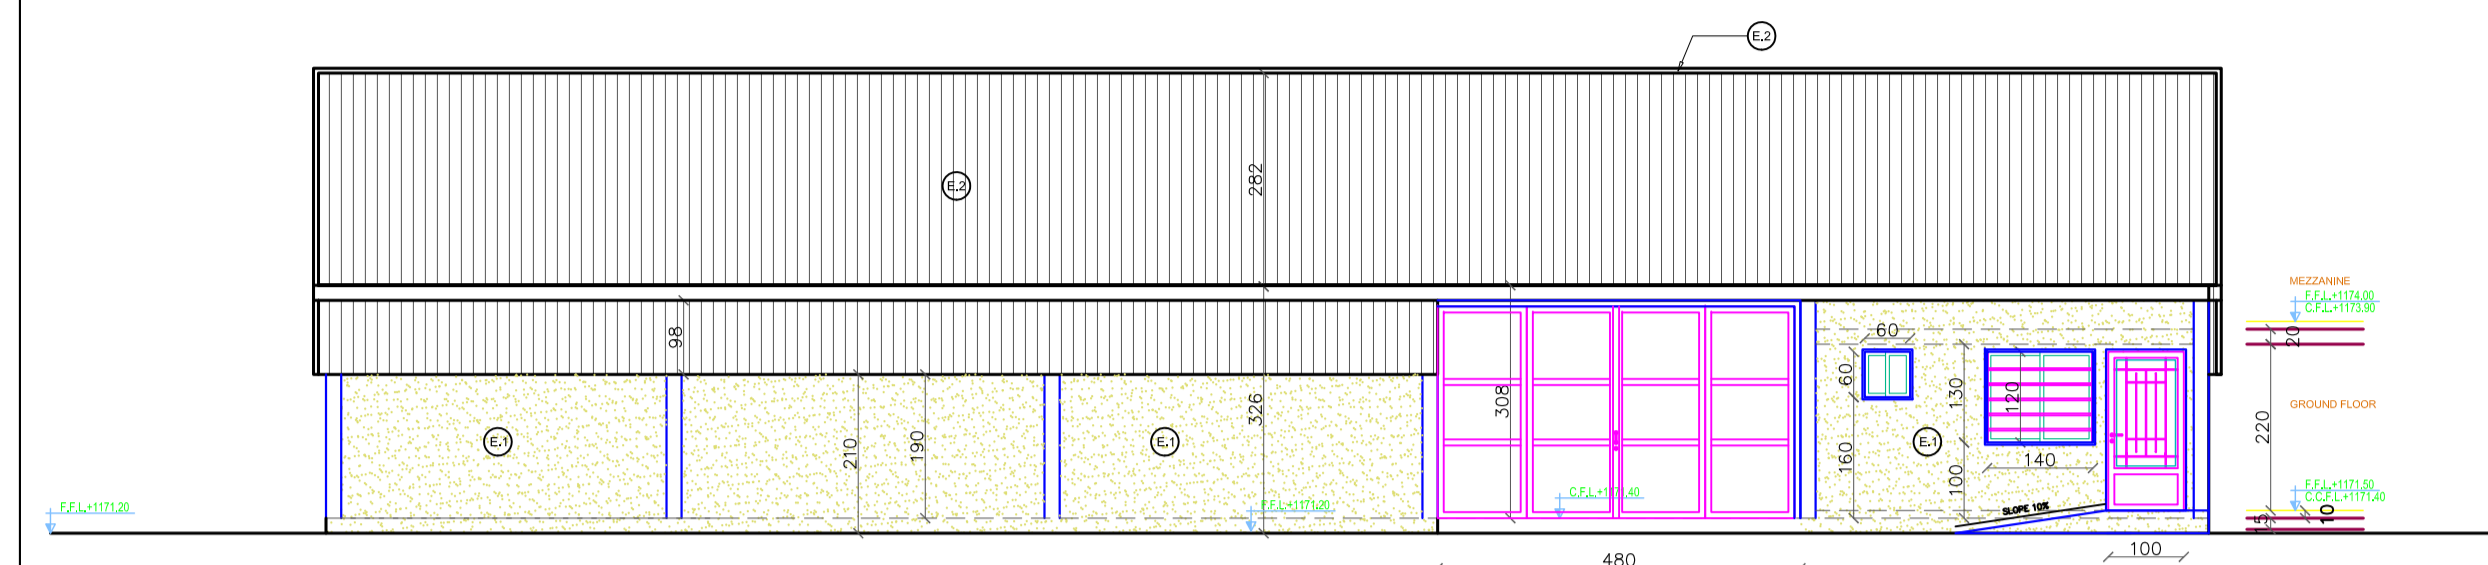


BLOCK A
EAST ELEVATION

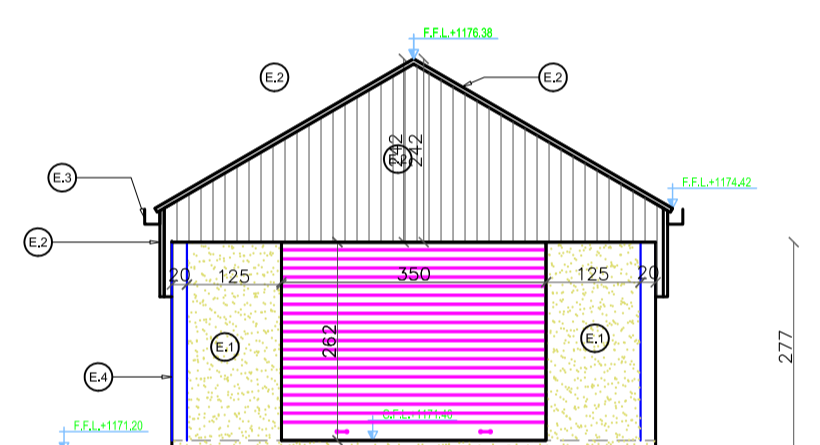

BLOCK B
EAST ELEVATION

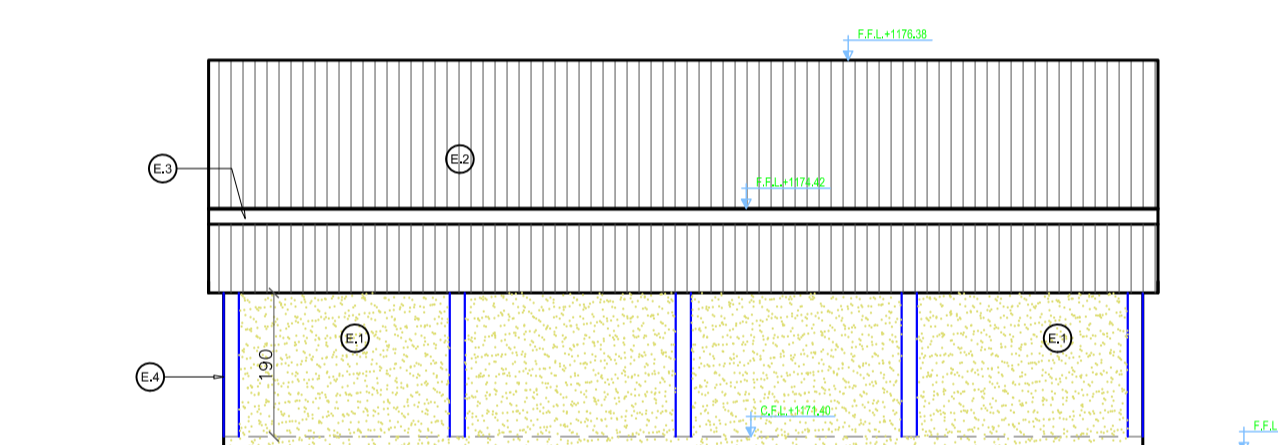


BLOCK B
SOUTH ELEVATION

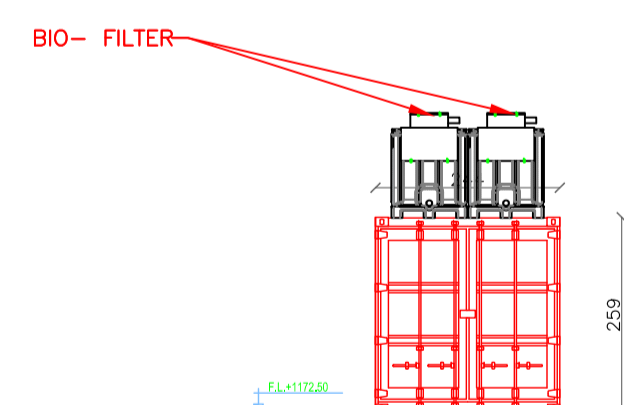

40' CONTAINER FOR COMPOSTING
MAIN ELEVATION

IMPORTANT NOTE:
THE DETAILED DRAWINGS OF THE CONTAINER COMPOSTER WILL BE PROVIDED IN A SEPARATE SUBMISSION

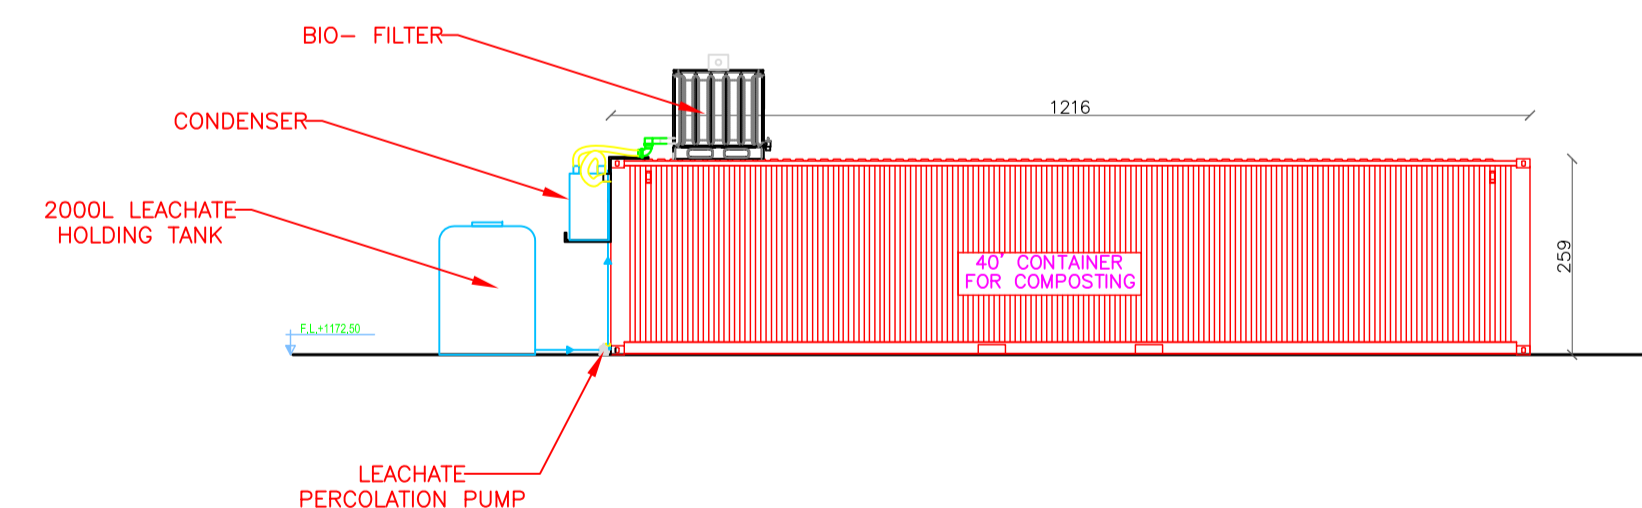

40' CONTAINER FOR COMPOSTING
SIDE ELEVATION

EXTERNAL FINISHES LEGEND

- E.1 MONOCOUCHEPAINT ON CEMENT SAND PLASTERED LAYER
- E.2 CORRUGATED G.I. SHEET
- E.3 GALVANIZED STEEL SHEETS GUTTER 2.5MM THICK
- E.4 STEEL COLUMN - REFER TO THE STRUCTURAL DRAWINGS FOR PAINTING DETAILS



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LOT:

JEZZINE 86

Project Name

COMPOSTING STATION
JEZZINE - SOUTH

DRAWING TITLE:

PRODUCTION LINE &
EQUIPMENT

DRAWING NUMBER A08

SCALE : 1/100 DATE : 20/07/2022

86

